


Planning

PEGASUS
GROUP

AR/P19-0093 (224059)

6 September 2022

Ecclesfield Parish Council
Council Offices
Mortomley Lane
High Green
Sheffield
S35 3HS

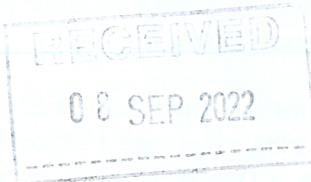

Dear Sir/Madam

EE Ltd and Hutchinson 3G UK Ltd

5G Mobile Connectivity

Industry Best Practice Informal Engagement

Installation of radio apparatus at Hesley Wood, White Lane, Chapel Town, Sheffield, South Yorkshire, S35 2YH (NGR E: 436105 N: 396540)

We write in connection with a proposal by EE Ltd and Hutchinson 3G UK Ltd, in conjunction with Mobile Broadband Network Limited (MBNL), who share the existing electronic communications installation, which is managed by Cellnex, a radio site infrastructure provider.

The Mobile Network Operators are proposing to upgrade this existing telecommunications installation and are writing to you as part of their informal engagement exercise prior to any planning application being submitted to Sheffield City Council. This consultation process is intended to be commensurate and appropriate to the development of comparatively small-scale essential public infrastructure development. Your co-operation with this informal process is therefore encouraged to help facilitate the balanced deployment of vital 5G next generation mobile communications infrastructure that will deliver clear benefits to your local area whilst proposing a scheme that is sensitive to the local area. In this case the operators intend to upgrade the existing electronic communications installation at the above site, rather than propose a new site elsewhere in the immediate surrounds.

There is a specific need for new apparatus to deliver 5G mobile connectivity to meet the Government's Digital Strategy and bring about the significant benefits associated with this advanced next generation mobile connectivity. The deployment of 5G will begin through utilising the MNOs existing 3G and 4G sites like this one and so for a period of time, sites are likely to carry different services in parallel, with intelligence applied to ensure high data uses operate through the higher capacity networks.

An upgrade of Cellnex's existing facility has been selected by the operators as this will provide the required level of network coverage while meeting national and local town planning policy objectives to share an existing electronic communications site. In this case the operators already have a base station operating from the site with services integrated into their wider mobile networks, so the

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option of developing an alternative site is not a realistic proposition as it would cause undue delay and disruption to 5G mobile connectivity in the area.

The proposed development entails the removal of a 22.5m mast and 3No. Antennas which will be replaced with a 25m monopole which will support 12No. Antennas, 1No. 0.6m HP Dish, 1No. relocated 0.3m HP Dish, RRHs, ERSs, BOBs, MHAs along with ancillary equipment. The enclosed drawings provide further details of the development.

It is important to emphasise that the provision of 5G requires more antennas due to the need to ensure resilient coverage and in some locations, particularly towns and cities, the operators may need additional antennas simply to meet network capacity requirements.

Within this context, we consider that the proposed apparatus looks to satisfactorily balance these various operational considerations and still minimise the extent of visual influence associated with the development atop this building.

Although the proposed development is situated atop a building, we consider that this will be acceptable in the planning balance when considered alongside the benefits of providing the operators advanced 5G network coverage and the extent to which the proposal meets local and national town planning policies for the shared use of existing electronic communication masts and sites.

The apparatus proposed requires a GPDO application is made to the Council. The availability of permitted development rights within the Order for installing apparatus clearly reflects the Government's strong emphasis towards the reuse and redevelopment of existing electronic communications installations to minimise the need for further structures elsewhere and this proposal clearly follows the emphasis within that particular guidance.

We invite any comments you may have on this proposal so that they can be taken into account, where possible, in finalising the development.

Although our application will be supported by, as a minimum, all necessary information to meet statutory or local validation requirements, we do welcome your opinion on any other information that might be reasonably required for your determination of the application, reflecting site specific considerations (such as heritage, landscape and ecology). In this way, Cellnex would look to bring forward a form of development and level of supporting information that best meets the LPA expectations (where reasonably possible) and to avoid undue delays during the planning process.

Other Engagement

In accordance with best practice guidelines and the advice contained in national policy, the operators are committed to undertaking wider engagement with the local community and other stakeholders who may have an interest in the development.



The proposal has, therefore, been assessed using Traffic Light Rating Model in order to establish an appropriate level of engagement. The proposal has been categorised as amber. In accordance with best practice guidelines, we propose to engage with Sheffield City Council.

If, however, you feel the rating to be incorrect or consider that other interested parties should be notified at this stage, then please let us know and pass on relevant contact details as soon as possible.

We look forward to receiving any comments you may have. It would be greatly appreciated if you could either forward your comments or, if preferred, contact us to arrange a meeting within the next 14 days.

Yours sincerely

A handwritten signature in blue ink that reads "Archie Roberts".

Archie Roberts

Planner

Pegasus Group on behalf of Cellnex

e-mail: archie.roberts@pegasusgroup.co.uk

Enc. Drawings

NOTES

NO 1025
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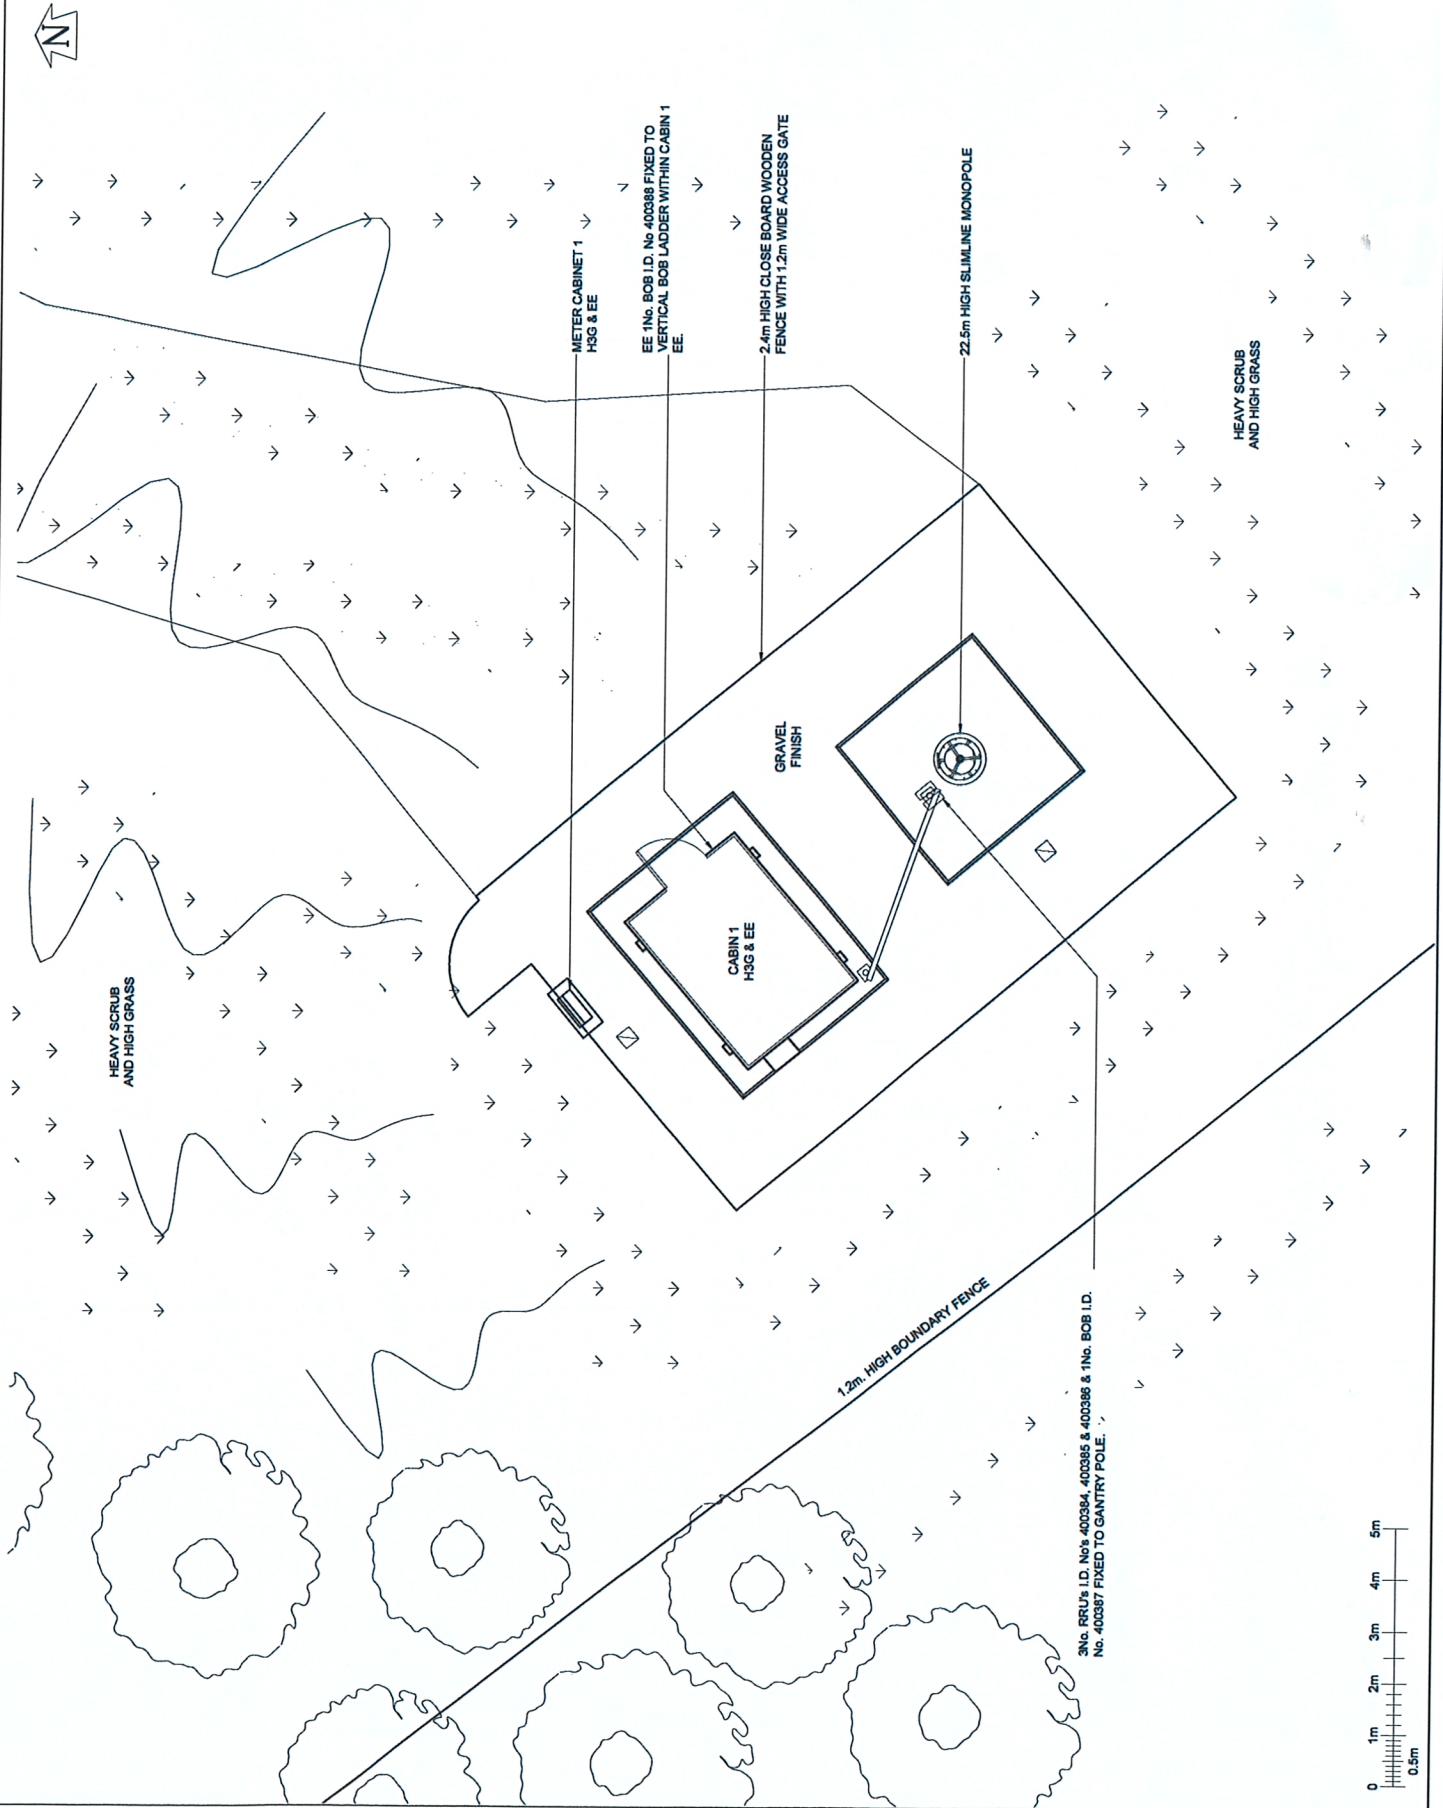


arQiva

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SITE No 1499932
HESELEY WOOD
HESELEY WOOD, WHITE LANE
CHAPELTOWN
SHEFFIELD
SOUTH YORKSHIRE

SCALE	1:2500	
DRAWN	HF	17/05/19
APPROVED	RF	17/05/19
DRG No.	Sheet 1 of 1	Rev
	1499932-00-010-ML001	1



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NOTES

H3G & EEE 3NQ. AQUA451BRO ANTENNAS AT 23.5m MEAN BEARINGS 355°.
 109°, & 228° E.T.N. I.D. No's 402268, 402267 & 402268
 BEARING 277 E.T.N. I.D. No 284281

TOP OF STRUCTURE: 22.5m
21.5m

23.75m

TOP OF STUDY

24

11

1

1

This technical site plan illustrates a complex facility layout. The upper portion features a large, multi-armed antenna system with a central mast and radiating arms. To the right of the antenna is a large, rectangular building complex with multiple levels and windows. In the foreground, there is a detailed view of ground-level equipment, including a tall vertical monopole, a ladder, and several cabinets labeled 'METER CABINET 1' and 'CABIN 1'. A boundary fence runs along the perimeter of the facility. Various dimensions are indicated throughout the plan, such as '23.75m', 'TOP OF STRUCTURE 22.5m', '21.5m', and '22.5m HIGH SLIMLINE MONPOLE'. Specific equipment labels include 'EE 1No. BOB I.D. No. 400388 FIXED TO VERTICAL BOB LADDER WITHIN CABIN 1 EE.', 'EE 3No. RRU's I.D. No's 400384, 400385 & 400386 & 1No. BOB I.D. No. 400387 FIXED TO GANTRY POLE. (BEHIND)', '2.4m HIGH CLOSE BOARD WOODEN - FENCE WITH 1.2m WIDE ACCESS GATE', and '1.2m. HIGH BOUNDARY FENCE'. Other labels include 'H3G & EE 3No. AQU45180 ANTENNAS AT 23.5m MEAN BEARINGS 355°, 108° & 229° E.T.N. I.D. No's 402266, 402267 & 402268', 'H3G & EE 1No. SHF 0.2m HP DISH AT 21.5m BEARING 277 E.T.N. I.D. No. 264281', and 'G.Loom'.

H3G & EE 3No. AQU45180 ANTENNAS AT 23.5m MEAN BEARINGS 355°, 108° & 229° E.T.N. I.D. No's 402266, 402267 & 402268

H3G & EE 1No. SHF 0.2m HP DISH AT 21.5m BEARING 277 E.T.N. I.D. No. 264281

23.75m

TOP OF STRUCTURE 22.5m

21.5m

22.5m HIGH SLIMLINE MONPOLE

METER CABINET 1
H3G & EE

CABIN 1
H3G & EE

EE 1No. BOB I.D. No. 400388 FIXED TO VERTICAL BOB LADDER WITHIN CABIN 1 EE.

EE 3No. RRU's I.D. No's 400384, 400385 & 400386 & 1No. BOB I.D. No. 400387 FIXED TO GANTRY POLE. (BEHIND)

2.4m HIGH CLOSE BOARD WOODEN - FENCE WITH 1.2m WIDE ACCESS GATE

1.2m. HIGH BOUNDARY FENCE

G.Loom

A3

NOTES



METER CABINET 1
FENCE WITH 1.2m WIDE ACCESS GATE

ACCESS TRACK

**HEAVY SCRUB
AND HIGH GRASS**

**PROPOSED 25.0m DM3 FLI HIGH CAPACITY MONPOLE TO BE
INSTALLED ON PROPOSED CONCRETE BASE (5.4m x 5.4m x 1.2m)**

22.5m HIGH SLIMLINE MONPOLE TO BE REMOVED

H3G & EE CABIN 1 TO BE REFRESHED FOR UPGRADE

EE ANCILLARY EQUIPMENT - 3No. RRU's & 1No. MK1 BOB FIXED TO GANTRY POLE TO BE REMOVED.

PROPOSED EE 1No. UHF GPS TO BE INSTALLED ON PROPOSED GANTRY POLE

PROPOSED H3G 1No. UHF GPS TO BE INSTALLED ON EXISTING

H3G & EE 3Nc. AQU451B&11 ANTENNAS AT 23.5m MEAN
GANTRY POLE

**PROPOSED HOG 6N0 H2a ANTENNAS TO BE INSTALLED AT 2400
BEARINGS 228°, 109° & 355° E.T.N. ID. No's. EQUB00210250,
EQUB00210249 & EQUB00210248 TO BE REMOVED**

MEAN BEARINGS 355°, 109° & 228° E.T.N. I.D. No's. EQUI00229184

PROPOSED H&G ANCILLARY EQUIPMENT -
12Nb. ERS's, 3Nb. REMOTE DC BOB's, 3Nb. REMOTE FIBRE BOB's,
3Nb. L14 FILTER's, 3Nb. MHA's & 6Nb. MULTI-MHA's TO BE

PROPOSED EE ANCILLARY EQUIPMENT

12NO. RR#1, 3NO. MK2 BOB's, 6NO. MHA's & 6NO. MULTI-MHA's TO BE INSTALLED AT 22.0m MEAN I.D. Nos. EQU900322832, EQU900310622, EQU900310621 & EQU900322834

RESERVED 1No. SHF 0.6m HP DISHES AT 21.5m MEAN.
H3G & EE 1No. SHF 0.3m HP DISH (ML93442) AT 21.5m BEARING
222777° E.T.N. I.D. No. EQU900256143 TO BE RELOCATED

→
BEARING D° E.T.N. I.D. No. EQU00278794 TO BE INSTALLED
(UNDER DIFFERENT PID)
PROPOSED 2N6. SHF 0.6m HP DISHES AT 23.5m MEAN.

BEARINGS 0° & 180° E.T.N. I.D. No's. EQU00277481 TO BE
INSTALLED

PROPOSED TEMPORARY TOWER
LOCATION

SCALE 1:100
DRAWN BY IM 16/08/11
APPROVED BY HFC 04/07/22
DRG No. Sheet 1 of 1 Rev
1499932-06-103-MD010 10
A3

**FEINT DETAILS INDICATE LOCATIONS
RESERVED FOR OTHER PROPOSALS
WHICH MAY BE THE SUBJECT OF
SEPARATE APPLICATIONS**

